


SECTION **A**  
SCALE: 3/16"=1'-0"  
M003

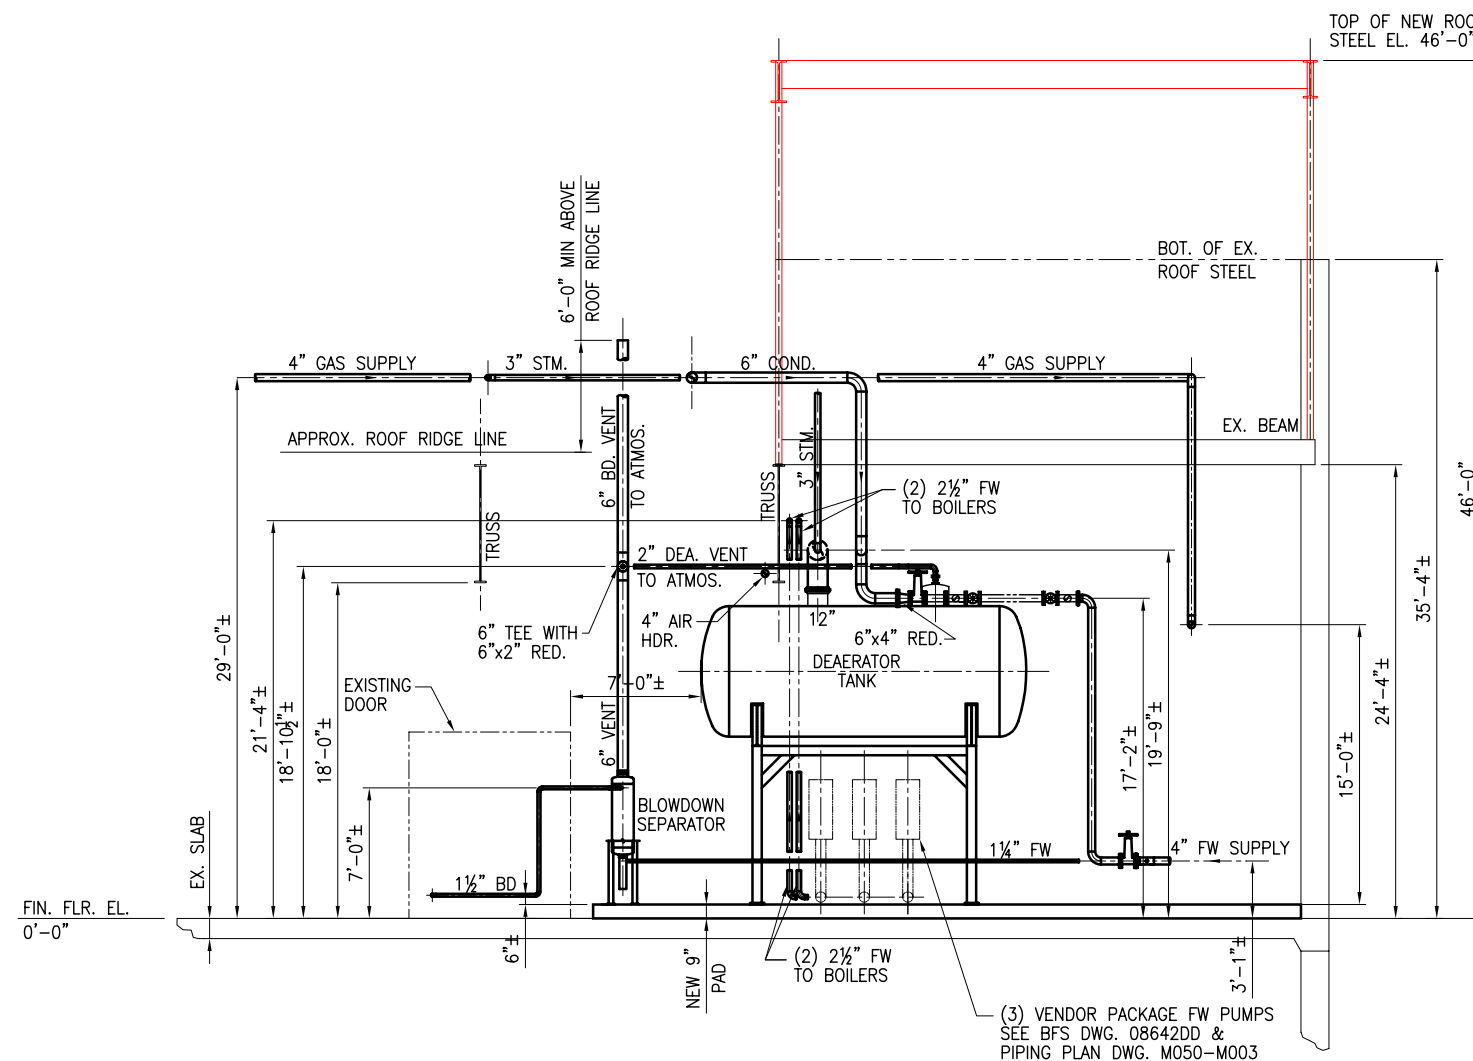

SECTION **B**  
SCALE: 3/16"=1'-0"  
M003

NOTES:

1. ALL ELEVATIONS SHOWN ARE FOR DESIGN PURPOSE. ELEVATIONS OF PIPE ROUTING MAY NEED TO BE FIELD ADJUSTED AS REQUIRED TO AVOID CONFLICTS WITH EXISTING CONDITIONS.
2. ALL DIMENSIONS ARE APPROXIMATE AND ARE FOR DESIGN PURPOSE. ALL DIMENSIONS ARE TO BE FIELD VERIFIED BY CONTRACTOR PRIOR TO START OF ANY WORK.
3. CONTRACTOR MAY NEED TO ADJUST PIPING SLIGHTLY TO ELIMINATE INTERFERENCE WITH EXISTING TRUSS.
4. BLOWDOWN PIPING FROM BOILERS TO BLOWDOWN TANK TO BE HELD IN PLACE AT FLOOR LEVEL WITH HIGH IMPACT POLYETHYLENE STRAPS. STRAPS TO BE SPACED ALONG PIPE AT APPROX. 3'-0" O.C. AND ANCHORED TO NEW CONCRETE FLOOR.
5. ACCESS PLATFORM AND LADDERS TO BE SHIPPED LOOSE BY EBT. CONTRACTOR WILL NEED TO MODIFY PLATFORM AND TOP ACCESS LADDER DUE TO SPACE RESTRICTIONS WITH EXISTING TRUSS. NEW TOP ACCESS LADDER WILL NEED TO EXTEND FROM NEW FLOOR SLAB TO ECONOMIZER ACCESS PLATFORM. LADDER WILL NEED TO BE LOCATED ON SIDE OF BOILER.
6. REFERENCE ROOF FRAMING DRAWINGS M050-S009 THRU M050-S013.

<b>H&amp;A, inc.</b> CONSULTING ENGINEERS Newtown Square, Pennsylvania 19073		DT. ISSUED	ISSUED FOR	0	ISSUED FOR CONSTRUCTION	TEE	2/17/09
		2/17/09	CONSTRUCTION	REV.	DESCRIPTION	BY	DATE
ASSEMBLY DWG.-		BY: T.E.E.	DATE: 1/5/09	<b>PAPERWORKS INDUSTRIES, INC.</b> PLANT - BOMBARD MILL ADDRESS - PHILADELPHIA, PA. INSTALLATION <b>BOILERS INSTALLATION</b>			
THIS PRINT IS THE EXCLUSIVE PROPERTY OF PAPERWORKS AND IS TO BE USED ONLY FOR THE PURPOSE LOANED AND RETURNED ON REQUEST AND IS CONFIDENTIAL, NOT TO BE COPIED OR REPRODUCED		CHK: R.M.S.	FILE				
REFERENCE DWGS.		APP.	SCALE AS NOTED	TITLE <b>PIPING LAYOUT ELEVATION SHEET 1 OF 2</b>			
		CAD DISK #		DEPARTMENT	AREA	CLASS	DWG. NO. <b>M050-M004</b>